MIAMI-DADE COUNTY, FLORIDA METRO-DADE FLAGLER BUILDING 140 WEST FLAGLER STREET, SUITE 1603 MIAMI, FLORIDA 33130-1563 (305) 375-2901 FAX (305) 375-2908

## NOTICE OF ACCEPTANCE (NOA)

STORMPROOF 8500 NW 64 Street Miami, FL 33166

#### Scope:

This NOA is being issued under the applicable rules and regulations governing the use of construction materials. The documentation submitted has been reviewed by Miami-Dade County Product Control Division and accepted by the Board of Rules and Appeals (BORA) to be used in Miami Dade County and other areas where allowed by the Authority Having Jurisdiction (AHJ).

This NOA shall not be valid after the expiration date stated below. The Miami-Dade County Product Control Division (In Miami Dade County) and/or the AHJ (in areas other than Miami Dade County) reserve the right to have this product or material tested for quality assurance purposes. If this product or material fails to perform in the accepted manner, the manufacturer will incur the expense of such testing and the AHJ may immediately revoke, modify, or suspend the use of such product or material within their jurisdiction. BORA reserves the right to revoke this acceptance, if it is determined by Miami-Dade County Product Control Division that this product or material fails to meet the requirements of the applicable building code.

This product is approved as described herein, and has been designed to comply with the Florida Building Code, including the High Velocity Hurricane Zone.

**DESCRIPTION:** Series "100" Aluminum Single Hung Windows (L.M.I.)

**APPROVAL DOCUMENT:** Drawing No. **04-026**, titled "Series "100" Single Hung Windows (L.M.I)", sheets 1 through 5 of 5, prepared by TILTECO, Inc., signed and sealed by Walter A. Tillit Jr., P.E., dated 03/03/04, bearing the Miami-Dade County Product Control Approval Stamp with the Notice of Acceptance number and expiration date by the Miami-Dade County Product Control Division.

# MISSILE IMPACT RATING: Large and Small Missile Impact

**LABELING:** Each unit shall bear a permanent label with the manufacturer's name or logo, city, state and following statement: "Miami-Dade County Product Control Approved", unless otherwise noted herein.

**RENEWAL** of this NOA shall be considered after a renewal application has been filed and there has been no change in the applicable building code negatively affecting the performance of this product.

**TERMINATION** of this NOA will occur after the expiration date or if there has been a revision or change in the materials, use, and/or manufacture of the product or process. Misuse of this NOA as an endorsement of any product, for sales, advertising or any other purposes shall automatically terminate this NOA. Failure to comply with any section of this NOA shall be cause for termination and removal of NOA.

**ADVERTISEMENT:** The NOA number preceded by the words Miami-Dade County, Florida, and followed by the expiration date may be displayed in advertising literature. If any portion of the NOA is displayed, then it shall be done in its entirety.

**INSPECTION:** A copy of this entire NOA shall be provided to the user by the manufacturer or its distributors and shall be available for inspection at the job site at the request of the Building Official.

This NOA consists of this page 1 and evidence page E-1 and E-2, as well as approval document mentioned above. The submitted documentation was reviewed by **Theodore Berman**, **P.E.** 

NOA No 04-0205.01 Expiration Date: April 08, 2009 Approval Date: April 08, 2004 Page 1

2/11/2004

#### **STORMPROOF**

#### **NOTICE OF ACCEPTANCE: EVIDENCE SUBMITTED**

#### A. DRAWINGS

- 1. Manufacturer's die drawings and sections.
- 2. Drawing No **04-026**, titled "Series "100" Single Hung Window (L.M.I.)" Sheets 1 through 5 of 5, prepared by TILETCO Inc., dated 03/03/04, signed and sealed by Walter A. Tillit Jr., P.E.

#### B. TESTS

- 1. Test reports on 1) Large Missile Impact Test per FBC, TAS 201-94
  2) Cyclic Wind Pressure Loading per FBC, TAS 203-94
  along with marked-up drawings and installation diagram of a single hung window, prepared by Hurricane Engineering and Testing Inc., Test Report No.
  HETI-03-1809, dated 4/17/03, signed and sealed by Rafael E. Droz-Seda, P.E.
- 2. Test reports on 1) Small Missile Impact Test per FBC, TAS 201-94
  2) Cyclic Wind Pressure Loading per FBC, TAS 203-94
  along with marked-up drawings and installation diagram of a single hung window, prepared by Hurricane Engineering and Testing Inc., Test Report No.
  HETI-03-1768, dated 1/17/03, signed and sealed by Rafael E. Droz-Seda, P.E.
- 3. Test reports on 1) Air Infiltration Test, per FBC, TAS 202-94
  - 2) Uniform Static Air Pressure Test, Loading per FBC, TAS 202-94
  - 3) Water Resistance Test, per FBC, TAS 202-94
  - 4) Large Missile Impact Test per FBC, TAS 201-94
  - 5) Cyclic Wind Pressure Loading per FBC, TAS 203-94 along with marked-up drawings and installation diagram of a single hung window, prepared by American Test Lab of South Florida, Test Report No. **ATL-0708.03-03**, dated 12/12/01, signed and sealed by Henry Hattem, P.E.

#### C. CALCULATIONS

1. Anchor Calculations, ASTM-E1300, and structural analysis, prepared by PGT Industries, dated 02/02/04, signed and sealed by Walter A. Tillit Jr., P.E.

#### D. QUALITY ASSURANCE

1. Miami Dade Building Code Compliance Office (BCCO).

## E. MATERIAL CERTIFICATIONS

- 1. Notice of Acceptance No. **01-1204.01** issued to "E.I. DuPont DeNemours" For "Sentry Glass R Plus" dated 01/17/02, expiring on 1/14/07.
- 2. Notice of Acceptance No. **00-1212.04** issued to "E.I DuPont DeNemours" for "Dupont Butacite R PVB" dated 02/15/01, expiring on 12/11/05.

Theodore Berman, P.E.

Deputy Director, Product Control Division

NOA No 04-0205.01

Expiration Date: April 08, 2009 Approval Date: April 08, 2004

## **STORMPROOF**

## NOTICE OF ACCEPTANCE: EVIDENCE SUBMITTED

## F. STATEMENTS

1. Statement letter of conformance and no financial interest, dated January 23, 2004, signed and sealed by Walter A. Tillit Jr., P.E.

## G. OTHER

1. Letter from the consultant stating that the product is in compliance with the Florida Building Code (FBC).

Mercue Lema Theodore Berman, P.E.

Deputy Director, Product Control Division

NOA No 04-0205.01

Expiration Date: April 08, 2009 Approval Date: April 08, 2004

## GENERAL NOTES AND SPECIFICATIONS FOR SERIES 100:

1. SERIES 100 SINGLE HUNG WINDOW-LARGE MISSILE IMPACT RESISTANT, SHOWN ON THIS PRODUCT APPROVAL DOCUMENT (P. A. D.) HAS BEEN VERIFIED FOR COMPLIANCE IN ACCORDANCE WITH THE 2001 EDITION OF THE FLORIDA BUILDING CÓDE.

WINDOW MAY BE INSTALLED AT HIGH VELOCITY HURRICANE ZONES.

DESIGN WIND LOADS SHALL BE DETERMINED AS PER SECTION 1619 OF THE ABOVE MENTIONED CODE. IN ORDER TO VERIFY THAT ANCHORS ON THIS P.A.D., AS TESTED, WERE NOT OVERSTRESSED, A 33% INCREASE IN ALLOWABLE STRESS FOR WIND LOADS WAS NOT USED IN THEIR ANALYSIS.

THIS WINDOW'S ADEQUACY FOR IMPACT AND CYCLIC RESISTANCE HAS BEEN VERIFIED IN ACCORDANCE WITH SECTION 1606.1.4 OF THE ABOVE MENTIONED CODE AS PER TAS-201, TAS-202, TAS-203 AS PER LAB REPORTS # HETI 03-1809 & ATL 0708.03-03 AND AS PER SUBMITTED STRUCTURAL CALCULATIONS, PERFORMED AS PER SECTION 1611 OF THE FLORIDA BUILDING CODE.

- 2. ALL ALUMINUM EXTRUSIONS SHALL BE ALUMINUM ASSOCIATION 6063-T6 ALLOY AND TEMPER (UNLESS OTHERWISE NOTED), WITH Fy = 25.0 ksi MINIMUM. THE THICKNESS OF ALL EXTRUSIONS SHALL BE AS SHOWN ON THIS DRAWING.
- 3. ALL SCREWS USED FOR ASSEMBLY CONNECTIONS (METAL TO METAL) TO BE STAINLESS STEEL 304 OR 316 AISI SERIES OR CORROSION RESISTANT COATED CARBON STEEL AS PER DIN 50018 WITH 50 ksi YIELD POINT AND 90 ksi TENSILE STRENGTH.
- 4. WOOD BUCKS BY OTHERS, MUST BE ANCHORED PROPERLY TO TRANSFER LOADS TO THE BUILDING STRUCTURE. WOOD BUCKS MUST BE SOUTHERN PINE W/ G = 0.55. WOOD BUCKS NOT BY STORMPROOF, MUST SUSTAIN LOADS IMPOSED BY GLAZING SYSTEM AND TRANSFER THEM TO THE BUILDING STRUCTURE.
- 5. ANCHORS NOTES: ANCHORS TO WALL SHALL BE AS FOLLOWS:
- (A) TO EXISTING POURED CONCRETE: (Min. f'c = 3 ksi)
- 1/4"Ø TAPCON ANCHORS W/ 1 1/4" MIN EMBEDMENT, AS MANUFACTURED BY I.T.W. BUILDEX OR ELCO TEXTRON (COMPONENT (22)), THRU 1" P.T. WOOD BUCK.
- (B) TO EXISTING CONCRETE BLOCK WALL:
- 1/4"Ø TAPCON ANCHORS W/ 1 1/4" MIN EMBEDMENT, AS MANUFACTURED BY I.T.W. BUILDEX OR ELCO TEXTRON (COMPONENT (22)), THRU 1" P.T. WOOD BUCK.
- (C) TO EXISTING 2" P.T. WOOD BUCK:
- #14 FH WOOD SCREWS (NON CORROSIVE) W/ 1 1/2" MIN EMBEDMENT (COMPONENT (22A)
- 6. PROVIDE 1/4" MAX. SHIM SPACE (TYP.).

#### 7. THIS WINDOW WILL NOT REQUIRE A HURRICANE PROTECTION DEVICE.

- 8. PROVIDE SCHNEE MOREHEAD SEAM SEALER SM5504 SEALANT (TYP.) AT ALL FRAME AND SASH (VENT) JOINTS.
- 9. BALANCE MECHANISM NOT PART OF THIS APPROVAL, BUT SHALL BE CERTIFIED BY AN INDEPENDENT TESTING AGENCY.
- 10. REMAINING COMPONENTS FOR THIS WINDOW'S SYSTEM SHALL BE AS INDICATED ON BILL OF MATERIALS, SHEET 4 OF THIS DRAWING.

ONE LABEL SHALL BE PLACED FOR EVERY OPENING, LABEL SHALL READ AS FOLLOWS: STORMPROOF

MIAMI, FLORIDA

MIAMI-DADE COUNTY PRODUCT CONTROL APPROVED.

- 12. (a) THIS P.A.D. PREPARED BY THIS ENGINEER IS GENERIC AND DOES NOT PROVIDE INFORMATION FOR A SITE SPECIFIC PROJECT; i.e. WHERE THE SITE CONDITIONS DEVIATE FROM THE P.A.D.
- (b) CONTRACTOR TO BE RESPONSIBLE FOR THE SELECTION, PURCHASE AND INSTALLATION INCLUDING LIFE SAFETY OF THIS PRODUCT, BASED ON THIS P.A.D., PROVIDED HE/SHE DOES NOT DEVIATE FROM THE CONDITIONS DETAILED ON THIS DOCUMENT. CONSTRUCTION SAFETY AT SITE IS THE CONTRACTOR'S RESPONSIBILITY.
- (c) THIS P.A.D. WILL BE CONSIDERED INVALID IF ALTERED BY ANY MEANS.
- (d) THIS P.A.D. SHALL BEAR THE DATE AND ORIGINAL SEAL AND SIGNATURE OF THE PROFESSIONAL ENGINEER OF RECORD THAT PREPARED IT.

Approved as complying with the Florida Baiding Code
Date 04 | 08 | 04

U 0

SERIES 100 LARGE MISSILE IMPACT SINGLE HUNG WINDOWS


www.stormproof.us

FAX.(305)418 ≥. ż S500

TO

DATE: 03-03-04 SCALE: AS SHOWN DWG. BY: CHK. BY:

DWG. No.: 04-026 SHEET 1 OF 5

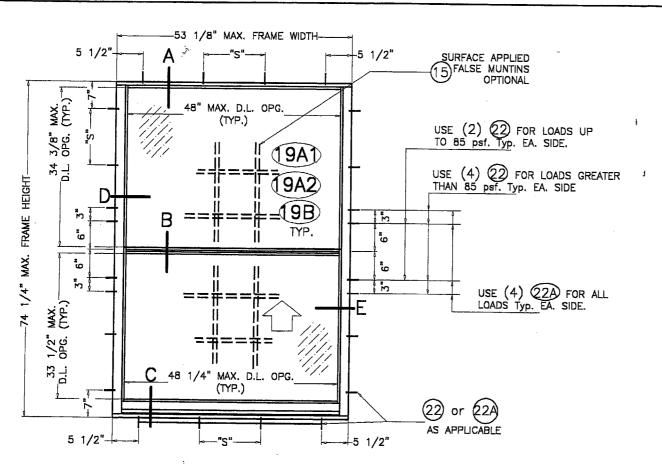

# SERIES 100 SINGLE HUNG WINDOW LARGE MISSILE IMPACT (EXTERIOR ELEVATION)

NTS


"S" = MAX. ANCHOR SPACING (SEE SCHEDULE)

SEE SECTIONS A, B, C, D & E ON SHEET 3

WINDOW TYPE *, PRESSURE RATING AND GLASS SCHEDULE							
WINDOW TYPE *	MAX. PRESSURE RATING (psf.)	GLASS TYPE	T1 GLASS (NOMINAL)	T2	T3 GLASS (NOMINAL)	Tt TOTAL	LAMINATED GLASS MANUFACTURER
SERIES 100 SINGLE HUNG WINDOW LARGE MISSILE	+85, -85	19A) .	1/8" HEAT STRENGTHENED	0.090" BUTACITE® PVB INTERLAYER	-	0.326"	E.I. DUPONT DENEMOURS & CO., INC.
	+100, -120	(9A2)	3/16" HEAT STRENGTHENED	0.090" BUTACITE® PVB INTERLAYER	-	0.462"	E.I. DUPONT DENEMOURS & CO., INC.
	+100, -120	19B	3/16" HEAT STRENGTHENED	0.090" DUPONT SENTRY GLAS® PLUS INTERLAYER	-	0.462"	E.I. DUPONT DENEMOURS & CO., INC.

	7 1 4 13711	_ 11.5111	101	A GIVEN	A AAUADOAA	11125
80	FRAMI	F WIDTH	FOR	A CIVEN	WINDOW	TVDE
₹	SEE E	LEVATION	NS FO	R MAX.	FRAME I	HEIGHT

SERIES 100 MAX. ANCHOR SPACING SCHEDULE							
LOCATION	ANCHOR	"S"					
LOGITION	TYPE	CONCRETE	BLOCK	WOOD			
SILL & HEAD	22	14"	14"	_			
	22A		_	9"			
JAMBS	22	12"	12"	-			
	22A	-	-	9"			

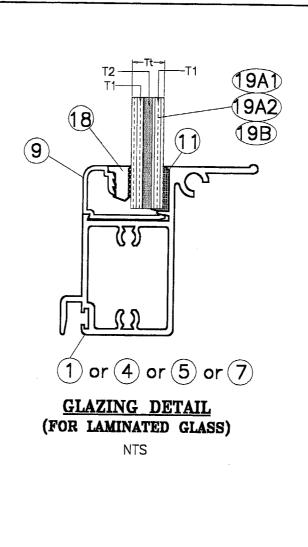


Approved as complying with the Florida Baiding Code
Date 04 08 04
NOA# 04-0205.01
Miami Dade Product Control
Division
By Hardy Bay


DWG. No.: **04-026**SHEET 2 OF 5

SERIES 100 LARGE MISSILE IMPACT SINGLE HUNG WINDOWS

MIAMI. FL.

Jour € € 3/3/00

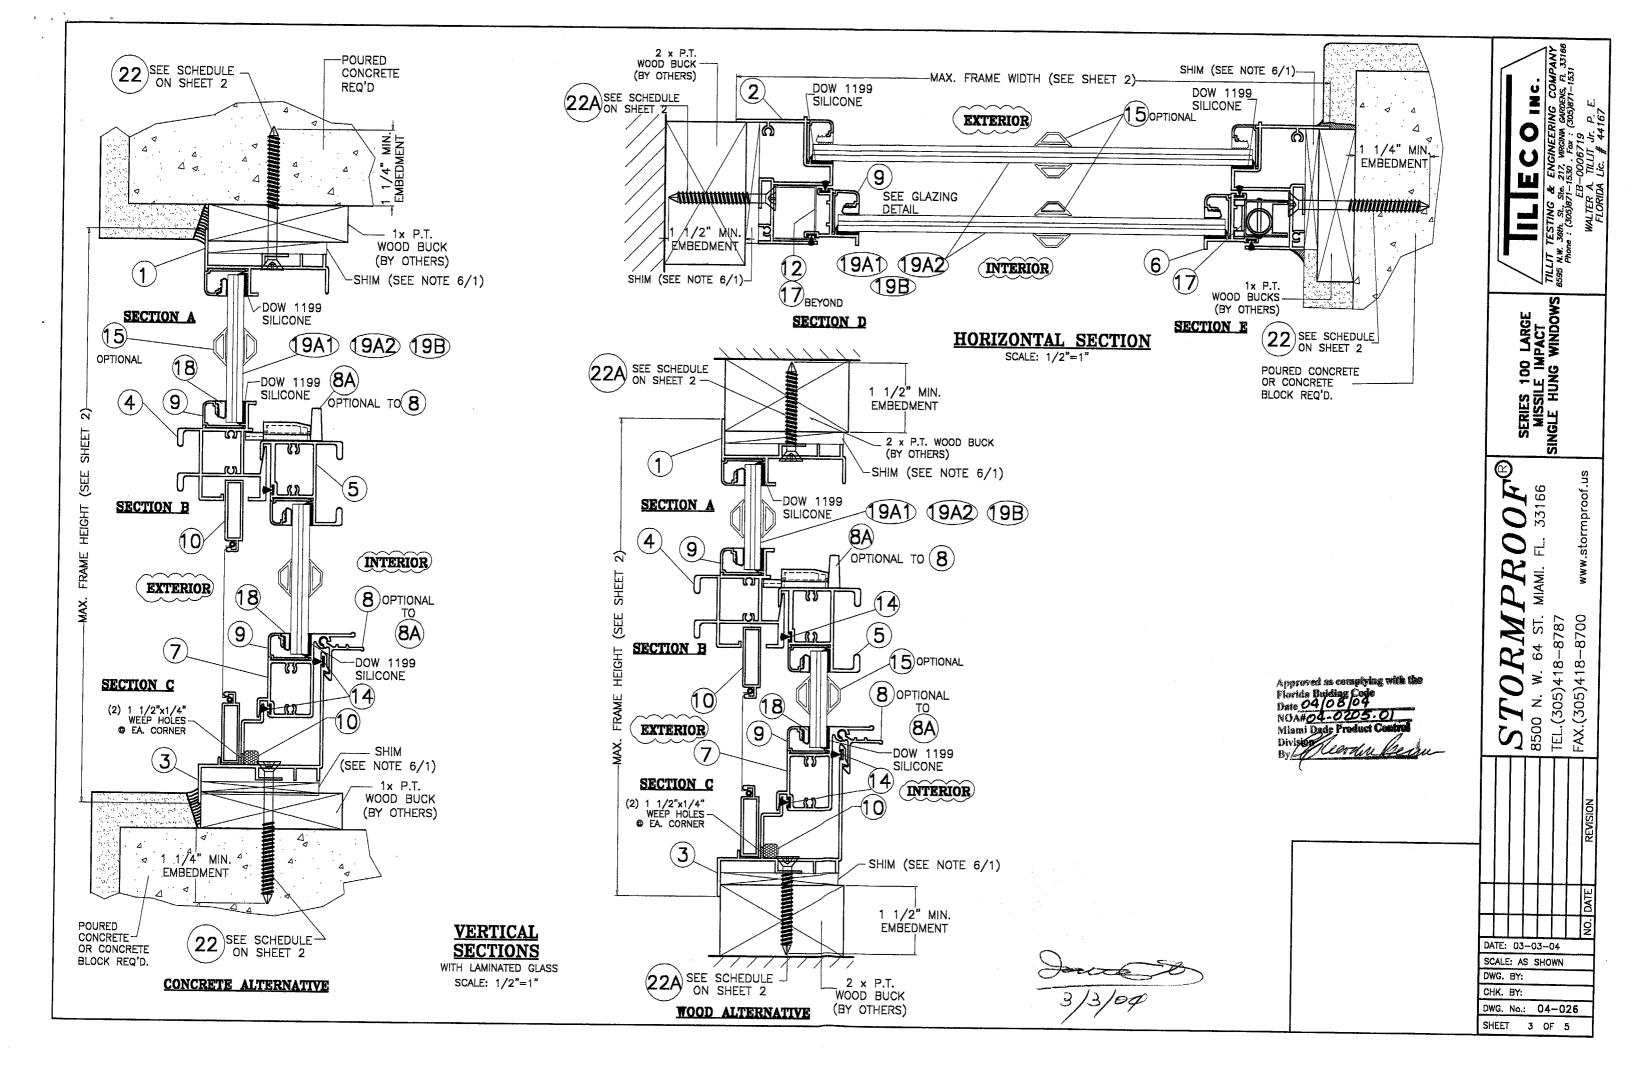

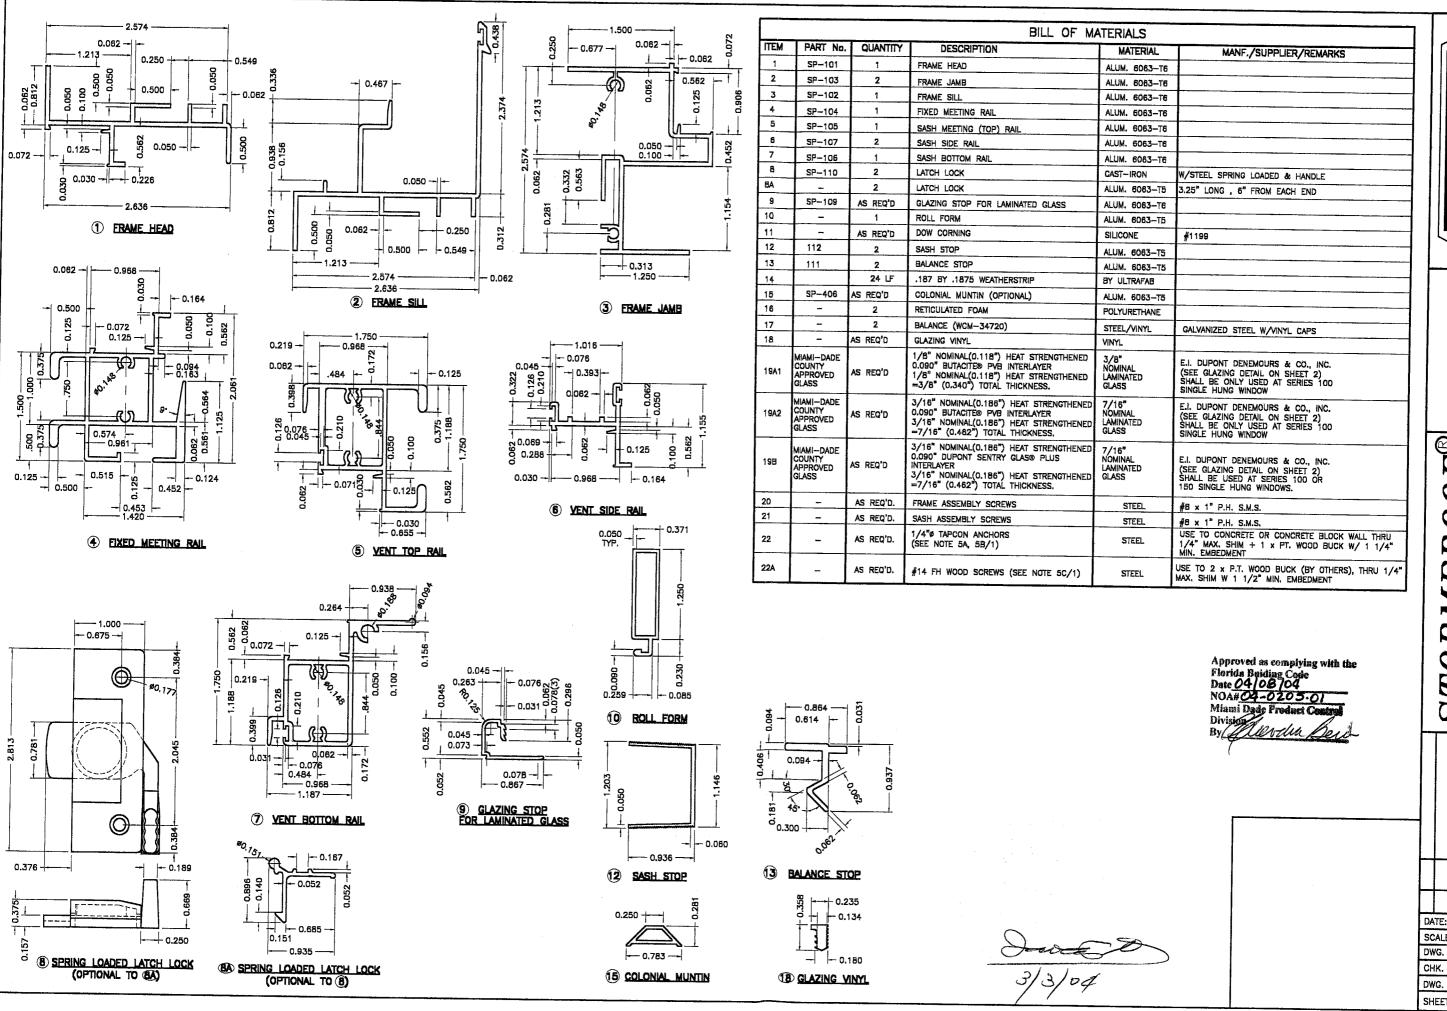

0 ES 100 LARGE SSILE IMPACT HUNG WINDOWS SERIES MISSIL SINGLE HU E CO

7

33166 ST. -8787 64 2 ≶ (305)ż

www.stormproof.us


-8700


FAX.(305)418 8500 Ħ.

DATE: 03-03-04 SCALE: AS SHOWN DWG. BY:

CHK. BY:

DWG. No.: 04-026 SHEET 4 OF 5

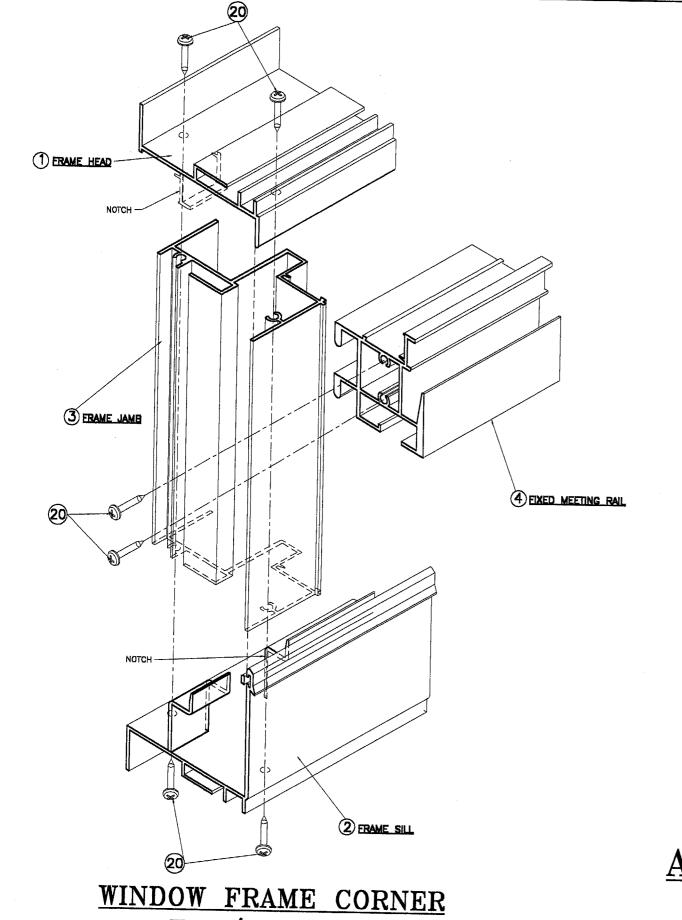

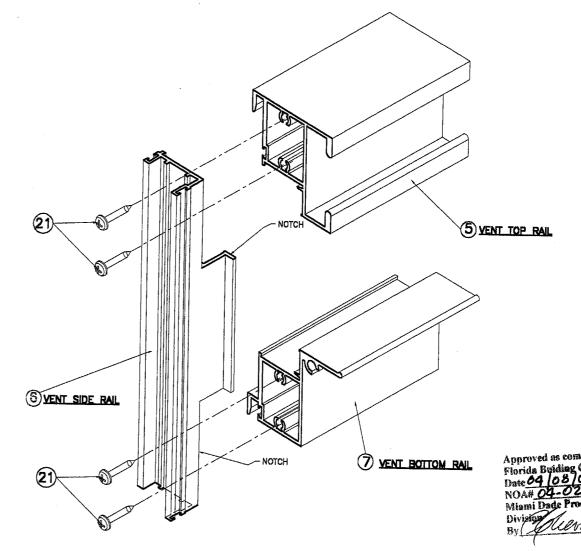


SASH (VENT) CORNER
TOP/BOTTOM (INTERIOR VIEW)

ASSEMBLY DETAILS

(SEE NOTE 8/1)

TOP/BOTTOM

JAMB/FIXED MEETING RAIL (INTERIOR VIEW)

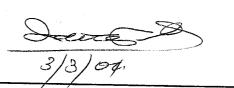

SERIES 10
33166 MISSILE 1
SINGLE HUNG

**XFFOOF** ST. MIAMI. FL. 3316 187

SUC N. W. 64 SI. EL.(305)418—8787 XX.(305)418—8700

E: D3-03-04 LE: AS SHOWN

DATE: 03-03-04
SCALE: AS SHOWN
DWG, BY:
CHK. BY:

DWG. No.: **04-026**SHEET 5 OF 5